### LIGHTING FIXTURE SCHEDULE

NOTE TO BIDDERS: COMPLY WITH SPECIFICATIONS. NOTIFY ENGINEER OF ANY DISCREPANCIES IN CATALOG NUMBERS LISTED. THE BIDDER IS RESPONSIBLE FOR PROVIDING ALL REQUIRED SPECIALITY MOUNTING KITS, AS REQUIRED BY THE RESPECTIVE FIXTURE(S) AND ALL ASSOCIATED ACCESSORIES FOR A COMPLETE INSTALLATION. PROVIDE WITHIN SEVEN (7) DAYS OF THE BID DATE UNIT PRICES FOR EACH LISTED FIXTURE TYPE FOR ADD/DELETE CHANGES WHICH MAY OCCUR. ALTERNATES TO THE LISTED FIXTURES MAY BE SUBMITTED PROVIDED THE ALTERNATE FIXTURE MATCHES THE LISTED FIXTURE IN ALL MATERIAL RESPECTS AS DETERMINED AT THE SOLE DISCRETION OF THE ELECTRICAL ENGINEER. THE BIDDER IS RESPONSIBLE FOR ANY COSTS ASSOCIATED WITH FIXTURES WHICH ARE DETERMINED NOT TO MATCH THE LISTED FIXTURE IN ALL MATERIAL RESPECTS.

CYMPOL	MADIZ	FIXTURE CHARACTERISTICS  BODY / AIR / MOUNTING / DOOR	LAMD	WA TTC	VOLTS	MANUEACTUR	ED CATALOG NUMBED	NOTES
SYMBOL	E	LENS/LOUVER/REFLECTOR/OTHER EMERGENCY BATTERY PACK CAPABLE OF USE WITH SWITCHED FIXTURE	LAMP	120/27	VOLTS 7V3W	BODINE	ER CATALOG NUMBER B30ST	NOTES
	E10	•	KGROUND. N	UST MEE	T NFPA II	LUMINATION STA	; LED LAMPS; EDGE LIGHTED CLEAR ANDARDS. UNITS SHOWN ARE CEILING UNITS WHERE REQUIRED.	
	E10-1	SINGLE FACE:	LED	20W	120/27	7V MCPHILBEN	45VL-1-RC-XX	
	E10-2	DUAL FACE:	LED	20W	120/27	7V MCPHILBEN	45VL-2-RM-XX	
	GF	TROFFERS: RECESSED FOR GYPSUM BALLASTS; T8 LAMPS; ONE BALLAS					DE; PROGRAM START ELECTRONIC	
	GF-1	FLUORESCENT RECESSED FIXTURE, 1X4, TWO LAMP.	2-F32T8 RE835	65W	277/120	OV PINNACLE	CJ14L-2T8-FL-UNV-1X-W-SI	
	GF-3	FLUORESCENT RECESSED FIXTURE, 2X4, TWO LAMP.	2-F32T8 RE835	65W	277/120	OV PINNACLE	CJ24L-2T8-FL-UNV-1X-W-SI	
	GS	TROFFERS: RECESSED FOR LAY-IN T8 LAMPS; ONE BALLAST PER FIXTU				GRADE; PROGRA	AM START ELECTRONIC BALLASTS;	
	GS-1	FLUORESCENT RECESSED FIXTURE, 1X4, TWO LAMP.	2-F32T8 RE835	65W	277/120	OV PINNACLE	CJ14L-2T8-GX-UNV-1X-W-SI	
	GS-2	FLUORESCENT RECESSED FIXTURE, 2X2, TWO LAMP.	2-F32T8 RE835	65W	277/120	OV PINNACLE	CJ22L-2T8-GX-UNV-1X-W-SI	
	GS-3	FLUORESCENT RECESSED FIXTURE, 2X4, TWO LAMP.	2-F32T8 RE835	65W	277/120	OV PINNACLE	CJ24L-2T8-GX-UNV-1X-W-SI	
	GS-5	2X2, 2 LAMP.	2-F31T8U RE835	65W	277/120	OV LUMAX	CGTV-2-U6-22-E0-9-FB-RS-PRS	
	SS						OGRAM START ELECTRONIC BALLASTS; T8 ING IS SHOWN ON THE PLANS, STEM MOUNTED	
	SS-1	4', 1 LAMP.	1-F32T8 RE835	33W	277/120	OV LUMAX	ER-1-32-48-E0-9-BS	
	SS-2	4', 2 LAMP.	2-F32T8 RE835	65W	277/120	OV LUMAX	ER-2-32-48-E0-9-BS	
	TX	SPECIAL FIXTURES AS INDICATED. M FINISH APPROVAL REQUIRED.	EET ALL RE	QUIREMEN	ITS OF SP	ECIFICATIONS AN	ND FIXTURE SCHEDULE. VISUAL AND	
	TX-1	FLUORESCENT WALL MOUNTED ARM (18") FIXTURE; PROVIDE ALL ACCESSORIES REQUIRED FOR A COMPLETE INSTALLATION	1-F28T5 RE835	30W	120V	TRANSLITE	USL4-18"-S-S-1-R-P-N	
	WB		ROGRAM ST	ART ELEC	CTRONIC B	ALLASTS; T8 LA	RD, ETC.): AS INDICATED ON DRAWINGS; MPS; ONE BALLAST PER FIXTURE WHERE	
	WB-3	2-LAMP, WALL MOUNT 48",	2-F32T8			OV LUMAX	SL-2-32-48-E0-9-CW-PRS	


VOLTS/PHASE/WIRE: PANEL SIZE & TYPE:					MAIN SIZE & TYPE:				LOCATION:	CABINET:			NOTES:				
20/2	240 V	, 1 PH	1 3 W	/IRE		22" W x 6" D, BOLT-ON	125	AMPERE	MAIN L	JGS	TENANT SPACE	SURFA	ACE				
ACCE	SSORI	ES:					•										
CKT OCP LOAD (kVA)		DESCRIPTION	LCL PHASEOAD		LCL	DESCRIPTION	LOAD (kVA)			OCP		Ck					
NO	AMP	POLE	LTG	СО	PWR		kVA	Α	В	kVA		LTG	СО	PWR	AMP	POLE	] N(
1	20	1		0.7		CORR./STOR. REC. (NOTE 1)	0.7	1.9		1.2	MICROWAVE (NOTE 1)			1.2	20	1	2
3	20	1		1.3		KIT./BATH REC. (NOTE 1)	1.3		2.5	1.2	REFRIGERATOR (NOTE 1)			1.2	20	1	4
5	20	1			1.2	COPIER (NOTE 1)	1.2	2.7		1.5	COFFEE MAKER (NOTE 1)			1.5	20	1	6
7	20	1		1.3		OFFICE REC. (NOTE 1)	1.3		1.4	0.2	KITCHEN REC. (NOTE 1)		0.2		20	1	8
9	20	1		1.3		OFFICE REC. (NOTE 1)	1.3	1.8		0.5	WATER COOLER (NOTE 1)			0.5	20	1	10
11	20	1		1.3		OFFICE REC. (NOTE 1)	1.3		1.3	0.0	SPACE				-	_	1:
13	20	1		1.1		CONF. RM. REC. (NOTE 1)	1.1	1.1		0.0	SPACE				-	_	14
15	20	1		1.3		RECEPT. REC. (NOTE 1)	1.3		1.3	0.0	SPACE				-	_	10
17	20	1	1.5		0.2	CORR. LTG. (NOTE 1)	2.0	1.6		0.0	SPACE				-	_	18
19	20	1			0.1	WATER HEATER (NOTE 1)	0.1		0.1	0.0	SPACE				-	_	2
21	20	1				EX. UNIT HEATER	0.0	0.0		0.0	SPACE				ı	_	2
23	20	1	1.6			OFFICE/KIT. LTG. (NOTE 1)	2.0		1.6	0.0	EX. LIGHTING				20	1	2
25	60	2			4.9	RTU-1	4.9	4.9		0.0	EX. LIGHTING				20	1	26
27	_	_			4.9	(NOTE 1)	4.9		4.9	0.0	EX. EMER. LTG.				20	1	28
29	20	1		0.4		EX. RECEPT.	0.4	0.4		0.0	EX. LIGHTING/RECEPT.				20	1	30
OTAL	₋S:					kVA PER F	PHASE	14	13		C	ONNEC	TED '	TOTAL	<sub>-</sub> kVA	27.3	
						AMPS PER F	PHASE	120	108		CONNECTED AVERA	AGE AN	/PS P	PER P	HASE	114	
NEC		SIFIED					ALL 07		NDC @10	\00 <del>7</del>	4.0.1574	בו ייבו		TOTA	VI 1.V/	Α.	
DE		HTING						THER LOA				DIVERS					4
KE	CEP I	ACLES	9K V P	A WIU	∪% =	9 kVA	Z3% (	OF LARGE	-21 MOI	UK =	0 kVA AVEF	RAGE A	4MP2	7EK	LUA2	_ =	11

RE835

### NOTES LEGEN


STEEL ENCLOSURE

1. PROVIDE NEW CIRCUIT BREAKER. MATCH EXISTING STANDARD BREAKER TYPE AND A.I.C. RATING.

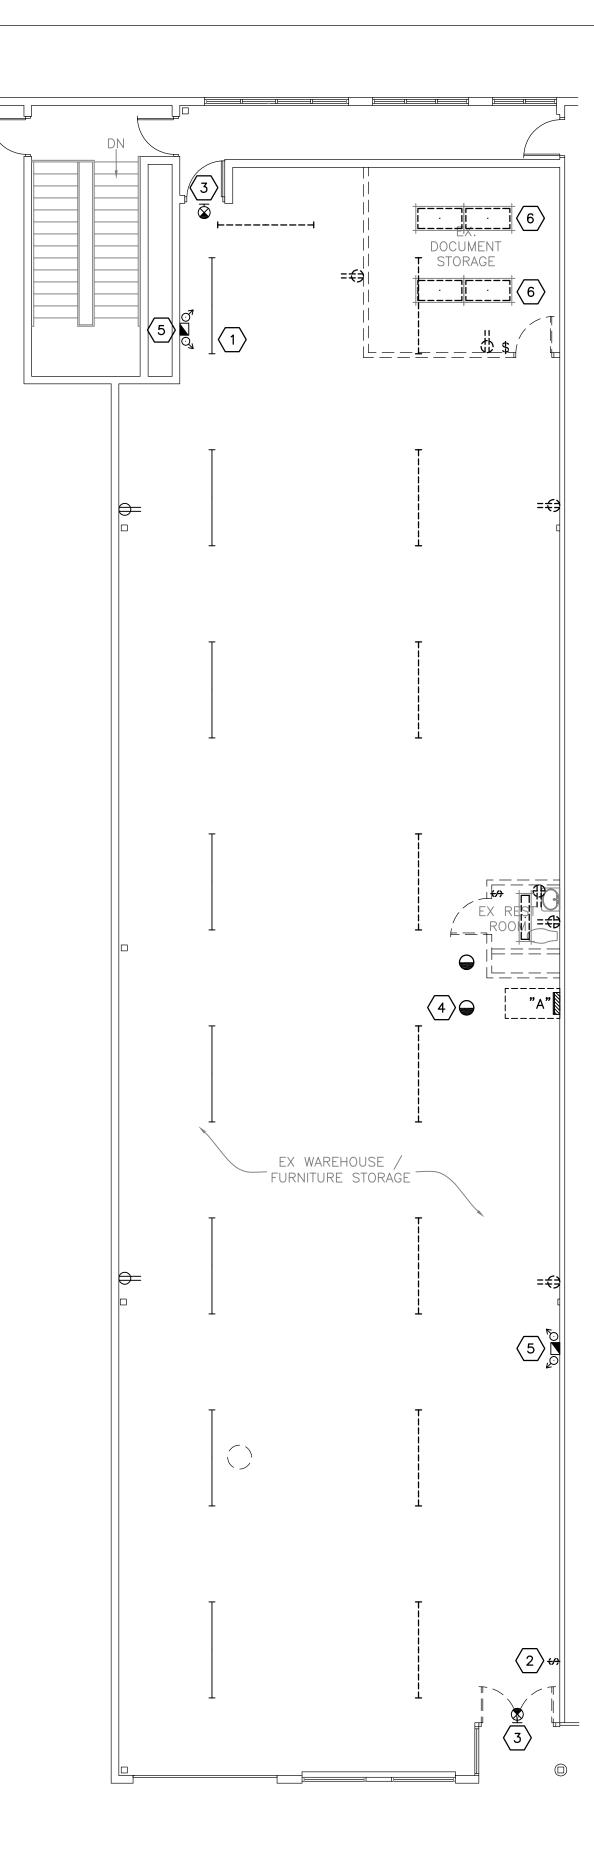

## GENERAL SHEET NOTES

1. REMOVE ALL CONDUIT AND CONDUCTORS ASSOCIATED WITH EXISTING DEVICES AND EQUIPMENT REMOVED DURING DEMOLITION TO NEAREST SOURCE. MAINTAIN CONTINUITY OF CIRCUITS SERVING EXISTING DEVICES AND LIGHT FIXTURES WHICH ARE EXISTING TO REMAIN.

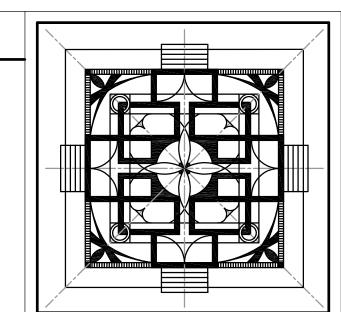

### SYMMETRY FIRST

## ARCHITECTS,

8600 Foundry Street
Box 2069
Savage, MD 20763
240-568-0700
240-568-0354 fax
www.symmetryfirst.com

### ○SHEET KEYNOTES

- EXISTING LIGHT FIXTURE TO BE RELOCATED. REFER TO LIGHTING PLAN FOR ADDITIONAL INFORMATION.
- 2. EXISTING SWITCH SERVING EXISTING OVERHEAD LIGHTING TO BE REMOVED. MAINTAIN EXISTING LIGHTING BRANCH CIRCUIT SERVING OVERHEAD LIGHTING FOR REUSE UNDER NEW WORK.
- EXISTING EXIT SIGN TO BE RELOCATED. REFER TO LIGHTING PLAN FOR ADDITIONAL INFORMATION.
- 4. EXISTING UNIT HEATER TO BE RELOCATED. REFER TO POWER PLAN FOR ADDITIONAL INFORMATION.
- 5. EXISTING EMERGENCY LIGHTING FIXTURE TO BE RELOCATED. REFER TO LIGHTING PLAN FOR ADDITIONAL INFORMATION.
- 6. REMOVE AND SALVAGE EXISTING RECESSED FLUORESCENT LIGHT

FIXTURES (QUANTITY: 4) FOR REUSE UNDER NEW WORK.

### STAMP

PROFESSIONAL CERTIFICATION: I HEREBY CERTIFY THAT
THESE DOCUMENTS WERE PREPARED OR APPROVED BY
ME, AND THAT I AM A DULY LICENSED PROFESSIONAL
ENGINEER UNDER THE LAWS OF THE STATE OF
MARYLAND.
LICENSE NO. 37060
EXPIRATION DATE: APRIL 20, 2013

NOTE: THESE DRAWINGS ARE THE PROPERTY OF SYMMETRY FIRST ARCHITECTS, LLC AND, AS SUCH, MAY NOT BE REPRODUCED OR RE-USED, EITHER WHOLLY OR IN PART, WITHOUT PRIOR WRITTEN CONSENT OF SYMMETRY FIRST ARCHITECTS, LLC.

### PROJECT PHASE BID

# DOCUMENTS

PROJECT TITLE

A.O.C. TENANT BUILD-OUT

2001COMMERCE PARK DR., SUITE 2001-B ANNAPOLIS, MD 21401

	REVIS	SIONS				
SYMBOL	DATE	ISSUED FOR				
$\triangle$	10.21.11	PERMIT REVISION				

PROJECT NUMBER 11-160
DATE 9.1.11

SCALE AS NOTED

DEMOLITION
PLAN AND

SCHEDULES

SHEET NUMBER

E.101

DEMOLITION FLOOR PLAN

SCALE: 1/8" = 1'-0"